


FOUNDATION "H"
SCALE: 1/2'=1'-0"





TYPICAL BEND

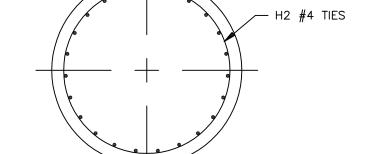

- H1 23-#8 BARS EQUALLY SPACED

REINFORCING STEEL

		FOR EACH FOUNDATION					
FOUNDATION	TOTAL NO. OF FOUNDATIONS	QTY	SIZE	LENGTH	MARK	TYPE	
Н	7	23	8	25'-6"	H1	STRAIGHT	
П	3	35	4		H2	T3	
ALL REINFORCING STEEL SHALL BE ASTM A615 GRADE 60.							

NOTES:

- OUTSIDE—TO—OUTSIDE DIAMETER OF NO. 4 CIRCULAR TIES SHALL BE 42".

 DRILLED PIER CONSTRUCTION SHALL CONFORM TO REQUIREMENTS OF
- 2. DRILLED PIER CONSTRUCTION SHALL CONFORM TO REQUIREMENTS OF THE PROJECT SPECIFICATIONS.
- 3. GEOTECHNICAL REPORT AVAILABLE FROM COTR.
- 4. REFERENCE ELEVATION: EXISTING GRADE AT LOCATION OF WEST PIER SHALL BE ASSUMED AS ELEVATION 100.00. THE CONTRACTOR SHALL REFERENCE THE ELEVATION TO THE ELEVATIONS OF THE TOP OF CONCRETE AT THE BASE OF THE EXISTING GUYED TOWER AND THE BUILDING FINISH FLOOR BEFORE STARTING CONSTRUCTION.


Refere	ence	Old	drawing	number:	


				UNITED STATES DEPARTMENT OF ENERGY SOUTHWESTERN POWER ADMINISTRATION TULSA, OKLAHOMA					
				HENRYETTA RADIO STATION MICROWAVE TOWER FOUNDATION					
				DRILLED PIER DETAILS					
				SCALE	NOTED	DRAWING NUMBER			
				DRAWN	DK	RS51-C8301			
				CHECKED	НМ	K331			
				SUBMITTED	НМ	FILE NAME	SHEET NUMBER		
REV	DESCRIPTION	DRAWN	CHKD	APPROVED	LH	C8301	1 OF 1		

- 1. SEE DWG. 1008-C8000 FOR SITE PLAN. 2. SEE DWG. RS51-C8501 FOR RADIO BUILDING WALL
- ELEVATIONS. 3. SEE DWG. RS51-C8700 FOR TOWER DETAILS.
- 4. SEE DWG. RS51-E3200 FOR GROUNDING PLAN AND DETAILS.
- PLAN AND DETAILS.

5. SEE DWG. RS51-E3100 FOR UNDERGROUND CONDUIT

6. SEE DWG. RS51-E2001 FOR ELECTRICAL ONE LINE AND PANELBOARD SCHEDULES.

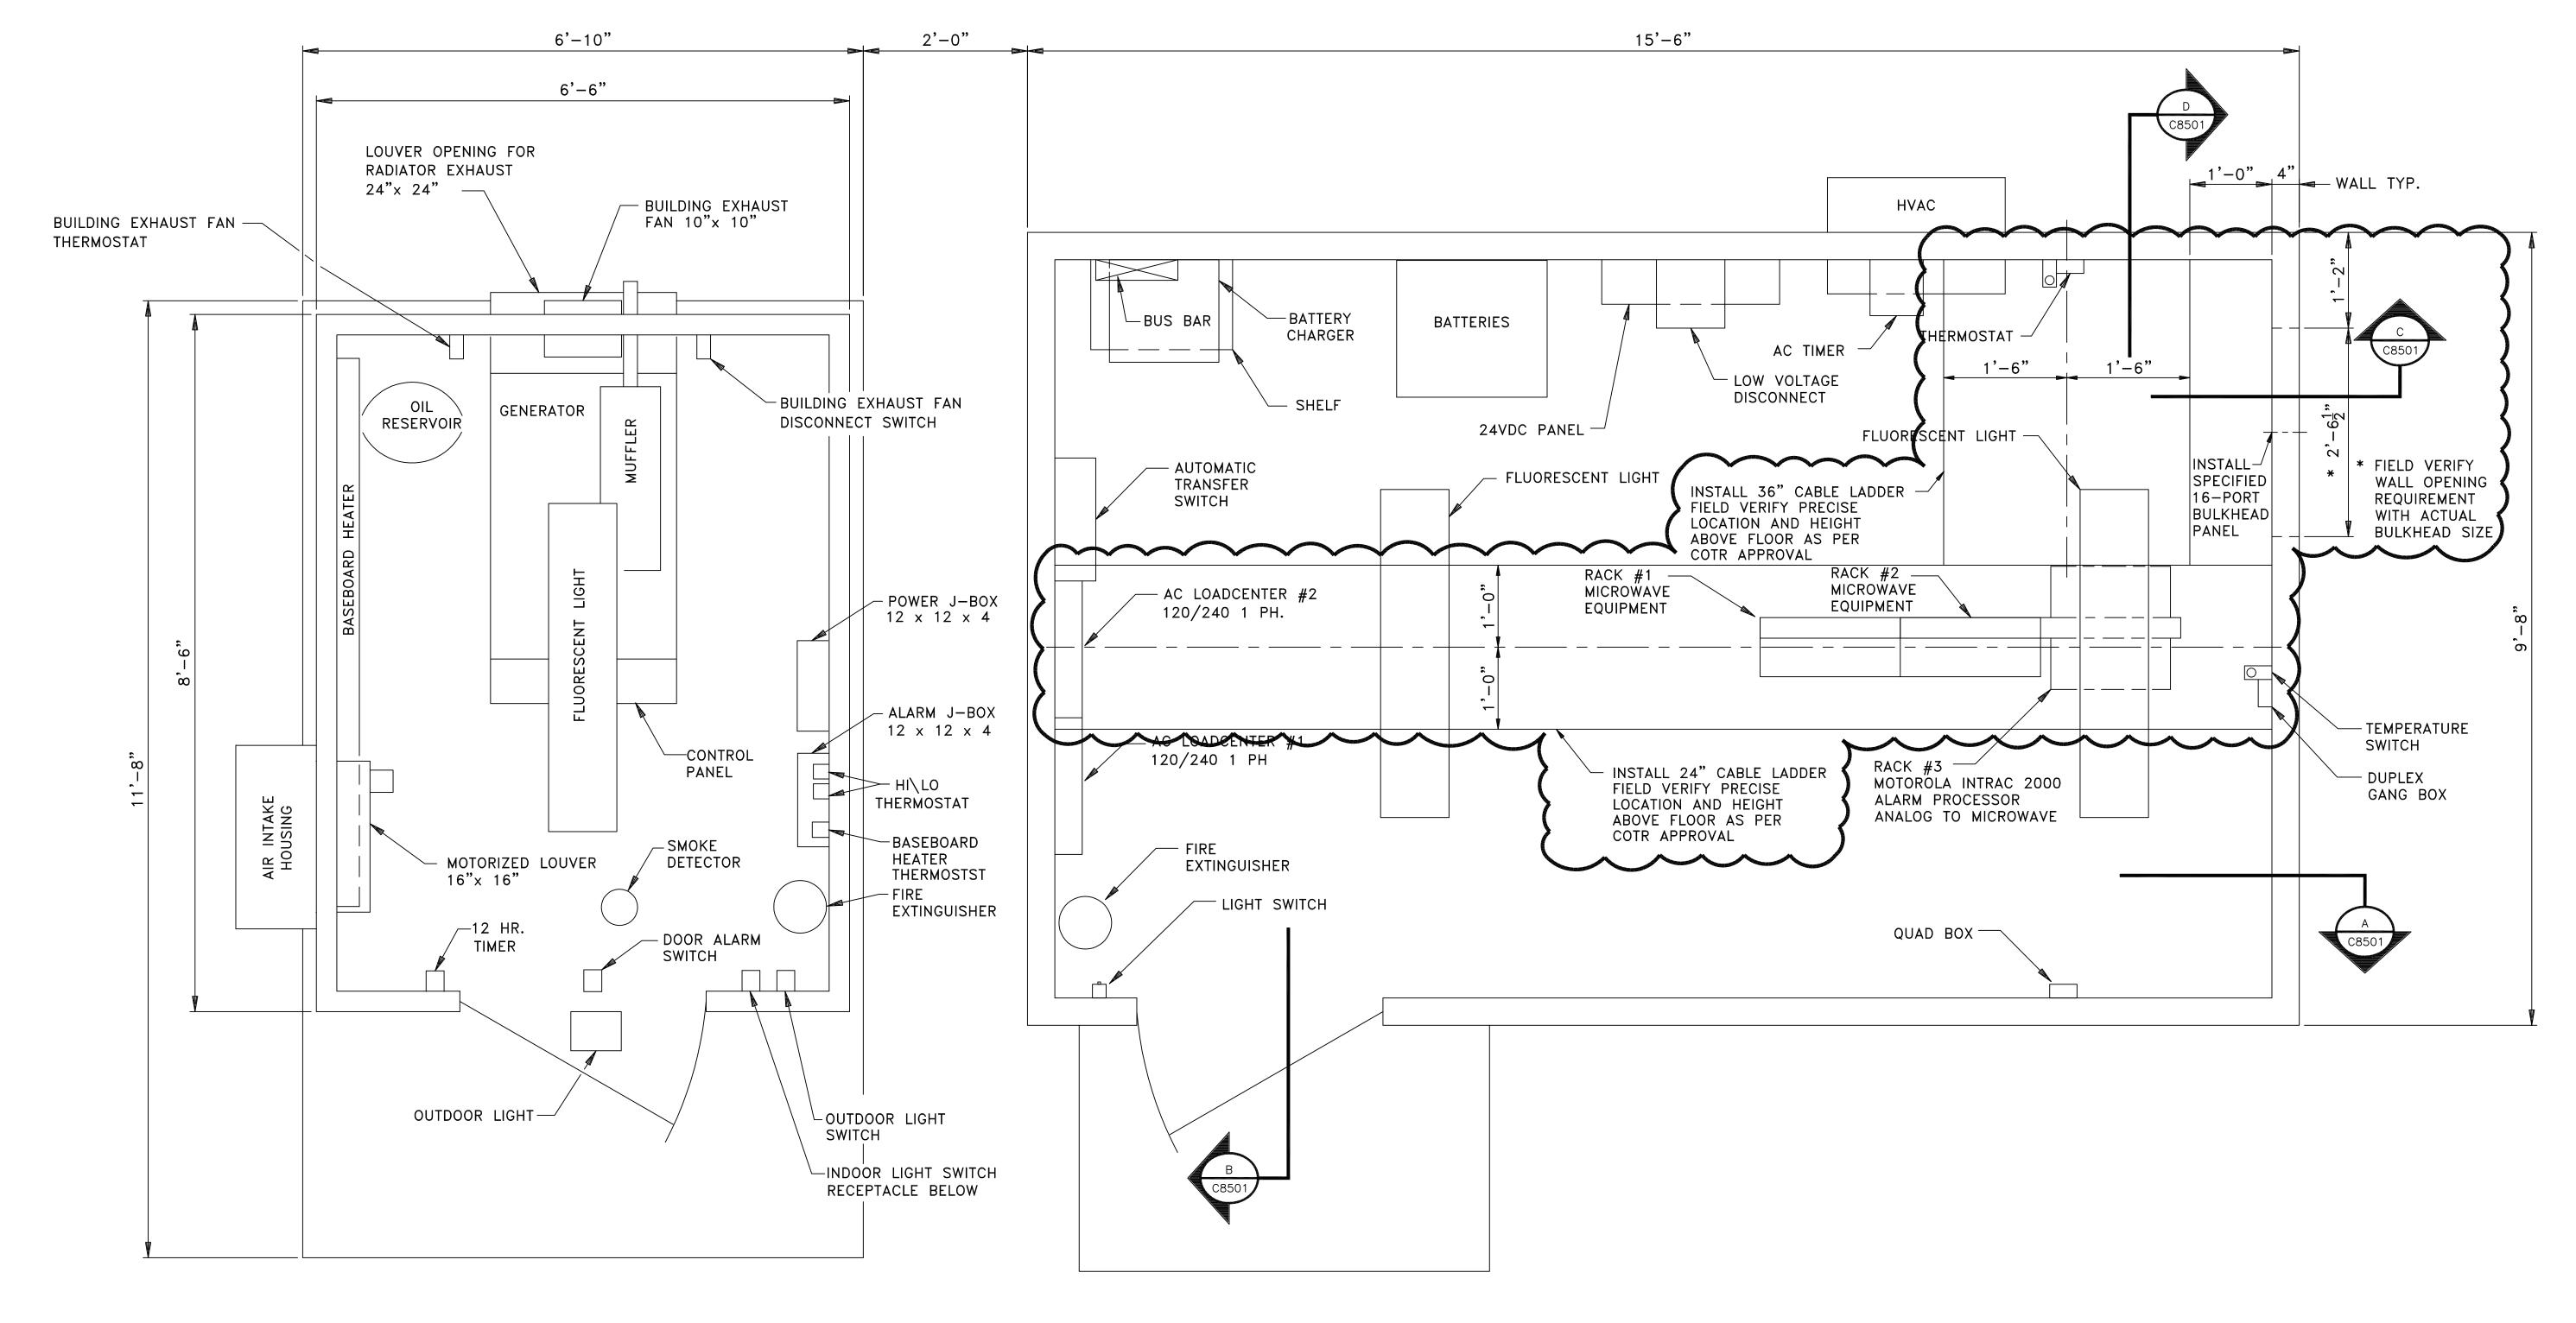

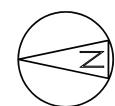

GENERATOR BUILDING PLAN SCALE: 1"=1'-0"

RADIO EQUIPMENT BUILDING PLAN SCALE: 1"=1'-0"

12" 9" 6" 3" 0

1"=1'-0"

	Reference Old drawing number:								
				UNITED STATES DEPARTMENT OF ENERGY SOUTHWESTERN POWER ADMINISTRATION TULSA, OKLAHOMA					
				HENRYETTA RADIO STATION RADIO AND GENERATOR BUILDING EQUIPMENT PLAN					
2	ADDITION OF CABLE LADDERS AND 16-PORT BULKHEAD PANEL	DK	НМ	SCALE	NOTED	DRAWING NUMBER			
		+	02-06	DRAWN	SWC 10/03	RS51-C	8500		
1	AS-BUILT	GBJ 10-04	SWC 10-04	SUBMITTED		FILE NAME	SHEET NUMBER		
REV	DESCRIPTION	DRAWN	CHKD	APPROVED		C8500	1 OF 1		

36 File